


PRECAST REINFORCEMENT SCHEDULE

PANELS	THICKNESS	FABRIC	VERT. REINF.	HORIZ. REINF.	PERIMETER BARS	DOWELS BTM. EDGE*
P1	200	SL92 EF	-	-	N16 EF	D2-500 CTS
P2	150	SL102 CENTRAL	-	-	=	D2-500 CTS
P3	150	-	N12-200 CENTRAL	N12-200 CENTRAL	=	D2-500 CTS
P4	150	-	N16-200 CENTRAL	N16-200 CENTRAL	=	D2-500 CTS
P4a	150	-	N16-200 CENTRAL	N16-200 CENTRAL	=	D3-400 CTS
P4b	150	-	N16-200 CENTRAL	N16-200 CENTRAL	=	D4-400 CTS
P5	150	-	N20-200 CENTRAL	N20-200 CENTRAL	=	D3-400 CTS
P5a	150	-	N20-200 CENTRAL	N20-200 CENTRAL	=	D4-400 CTS
P6	200	-	N12-200 EF	N12-200 EF	=	D3-400 CTS
P6a	200	-	N12-200 EF	N12-200 EF	=	D2-500 CTS
P7	200	-	N16-200 EF	N16-200 EF	=	D4-400 CTS
P7a	200	-	N16-200 EF	N16-200 EF	=	D3-400 CTS
P8	200	SL92 EF	-	-	=	D2-500 CTS
P9	200	-	N20-200 EF	N20-200 EF	=	D4-400 CTS

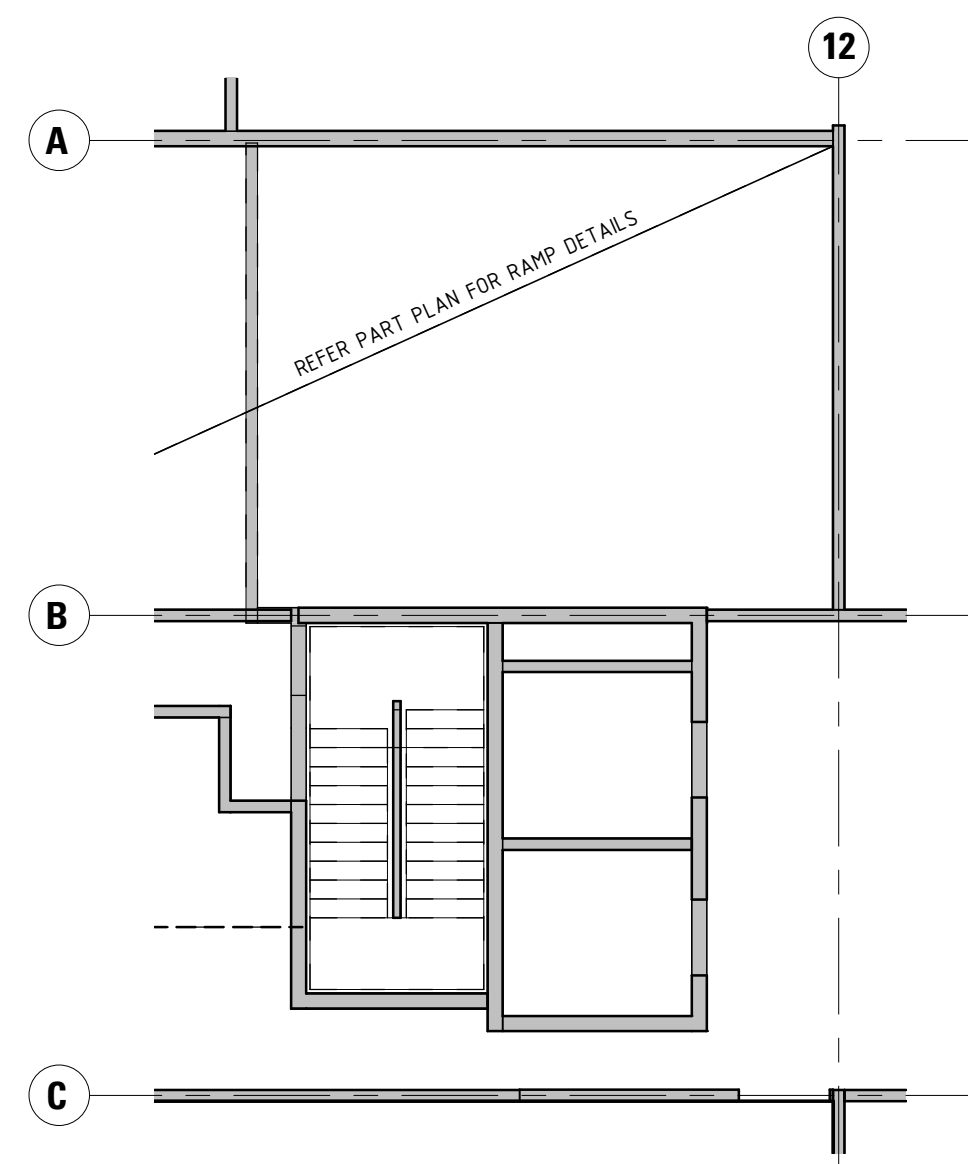

0 2500 5000 10000

SCALE 1:100 @ A1

04/10/19	ISSUED FOR CONSTRUCTION	00
Date	Revision	Issue

PT Design

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Approved	Approver	Date	04/10/2019 5:21:05 PM
		Sheet	

Project
HYDE PARK PLACE
248 UNLEY ROAD,
HYDE PARK SA

Client
CITIFY & BFC PTY LTD

Drawing Title
CORE ELEVATIONS
(Sheet 1)

Drawing Number
20492-S22

Name: P:\2018\20492\3.5 Drawings (S)\Revit 2019\20492 - Structural Model_ben.z6f38R.rvt Date/Time 04/10/2019 5:21:05 PM © Copyright