



PRECAST REINFORCEMENT SCHEDULE

PANELS	THICKNESS	FABRIC	VERT. REINF.	HORIZ. REINF.	PERIMETER BARS	DOWELS BTM. EDGE*
P1	200	SL92 EF	-	-	N16 EF	D2-500 CTS
P2	150	SL102 CENTRAL	-	-	=	D2-500 CTS
P3	150	-	N12-200 CENTRAL	N12-200 CENTRAL	=	D2-500 CTS
P4	150	-	N16-200 CENTRAL	N16-200 CENTRAL	=	D2-500 CTS
P4a	150	-	N16-200 CENTRAL	N16-200 CENTRAL	=	D3-400 CTS
P4b	150	-	N16-200 CENTRAL	N16-200 CENTRAL	=	D4-400 CTS
P5	150	-	N20-200 CENTRAL	N20-200 CENTRAL	=	D3-400 CTS
P5a	150	-	N20-200 CENTRAL	N20-200 CENTRAL	=	D4-400 CTS
P6	200	-	N12-200 EF	N12-200 EF	=	D3-400 CTS
P6a	200	-	N12-200 EF	N12-200 EF	=	D2-500 CTS
P7	200	-	N16-200 EF	N16-200 EF	=	D4-400 CTS
P7a	200	-	N16-200 EF	N16-200 EF	=	D3-400 CTS
P8	200	SL92 EF	-	-	=	D2-500 CTS
P9	200	-	N20-200 EF	N20-200 EF	=	D4-400 CTS

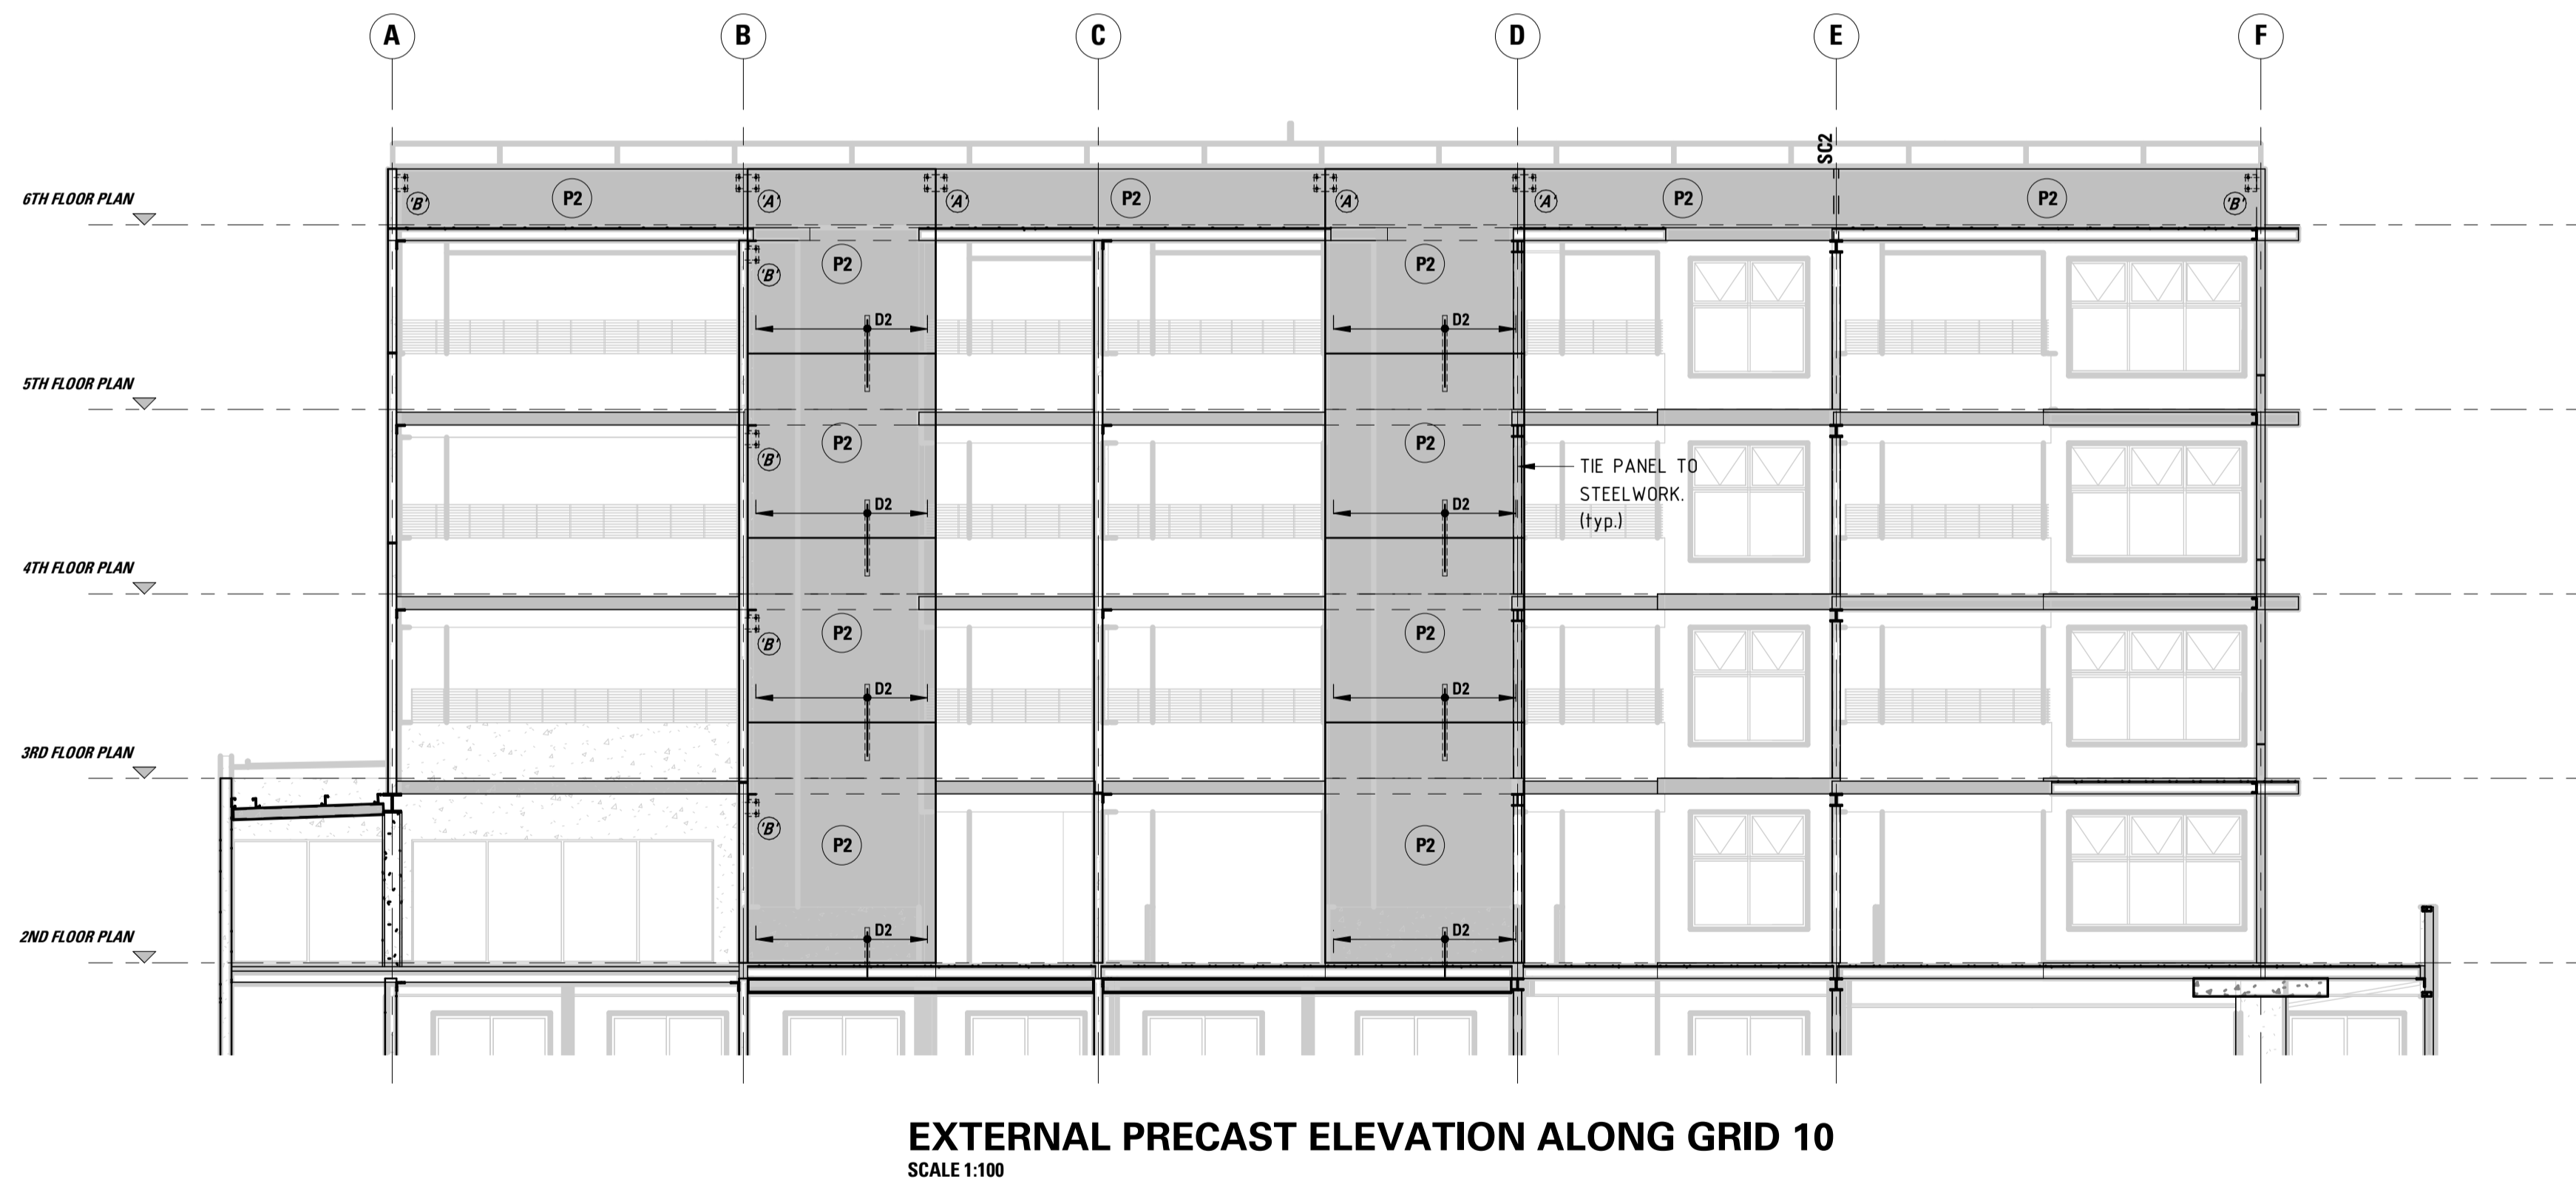

REFER TO SERVICES DRAWING
FOR LOCATION AND SIZE OF
WALL PENETRATIONS

FOR CONSTRUCTION

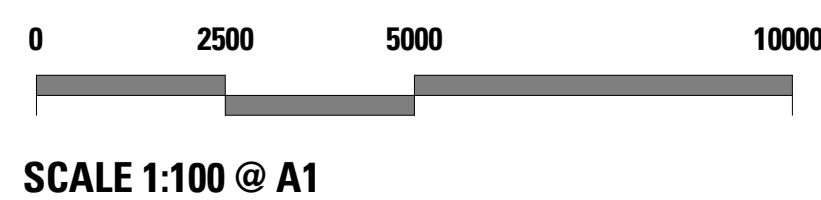

04/10/19 Date				ISSUED FOR CONSTRUCTION Revision				00 Issue			
PT Design											
PT Design Associates Pty Ltd 141-149 Hould St Adelaide SA 5000 T [08 8412 4300] F [08 8232 4311] E [ptdesign@ptdesign.net.au]											
Designer RW		Drawn BZ & MM		Approved Approver		Date 04/10/2019 5:17:27 PM		Sheet 11 of x			
Project HYDE PARK PLACE 248 UNLEY ROAD, HYDE PARK SA											
Client CITIFY & BFC PTY LTD										N +	
Drawing Title EXTERNAL ELEVATIONS (Sheet 3)										Scale As indicated	
Drawing Number 20492-S14										Issue 00	
Name: P:\2018\20492\3.5 Drawings (S)\Revit 2019\20492 - Structural Model_ben.z6f38R.rvt Date/Time 04/10/2019 5:17:27 PM ; © Copyright											