



NORTH ELEVATION
SCALE 1:100

PRECAST REINFORCEMENT SCHEDULE

PANELS	THICKNESS	FABRIC	VERT. REINF.	HORIZ. REINF.	PERIMETER BARS	DOWELS BTM. EDGE*
P1	200	SL92 EF	-	-	N16 EF	D2-500 CTS
P2	150	SL102 CENTRAL	-	-	=	D2-500 CTS
P3	150	-	N12-200 CENTRAL	N12-200 CENTRAL	=	D2-500 CTS
P4	150	-	N16-200 CENTRAL	N16-200 CENTRAL	=	D2-500 CTS
P4a	150	-	N16-200 CENTRAL	N16-200 CENTRAL	=	D3-400 CTS
P4b	150	-	N16-200 CENTRAL	N16-200 CENTRAL	=	D4-400 CTS
P5	150	-	N20-200 CENTRAL	N20-200 CENTRAL	=	D3-400 CTS
P5a	150	-	N20-200 CENTRAL	N20-200 CENTRAL	=	D4-400 CTS
P6	200	-	N12-200 EF	N12-200 EF	=	D3-400 CTS
P6a	200	-	N12-200 EF	N12-200 EF	=	D2-500 CTS
P7	200	-	N16-200 EF	N16-200 EF	=	D4-400 CTS
P7a	200	-	N16-200 EF	N16-200 EF	=	D3-400 CTS
P8	200	SL92 EF	-	-	=	D2-500 CTS
P9	200	-	N20-200 EF	N20-200 EF	=	D4-400 CTS

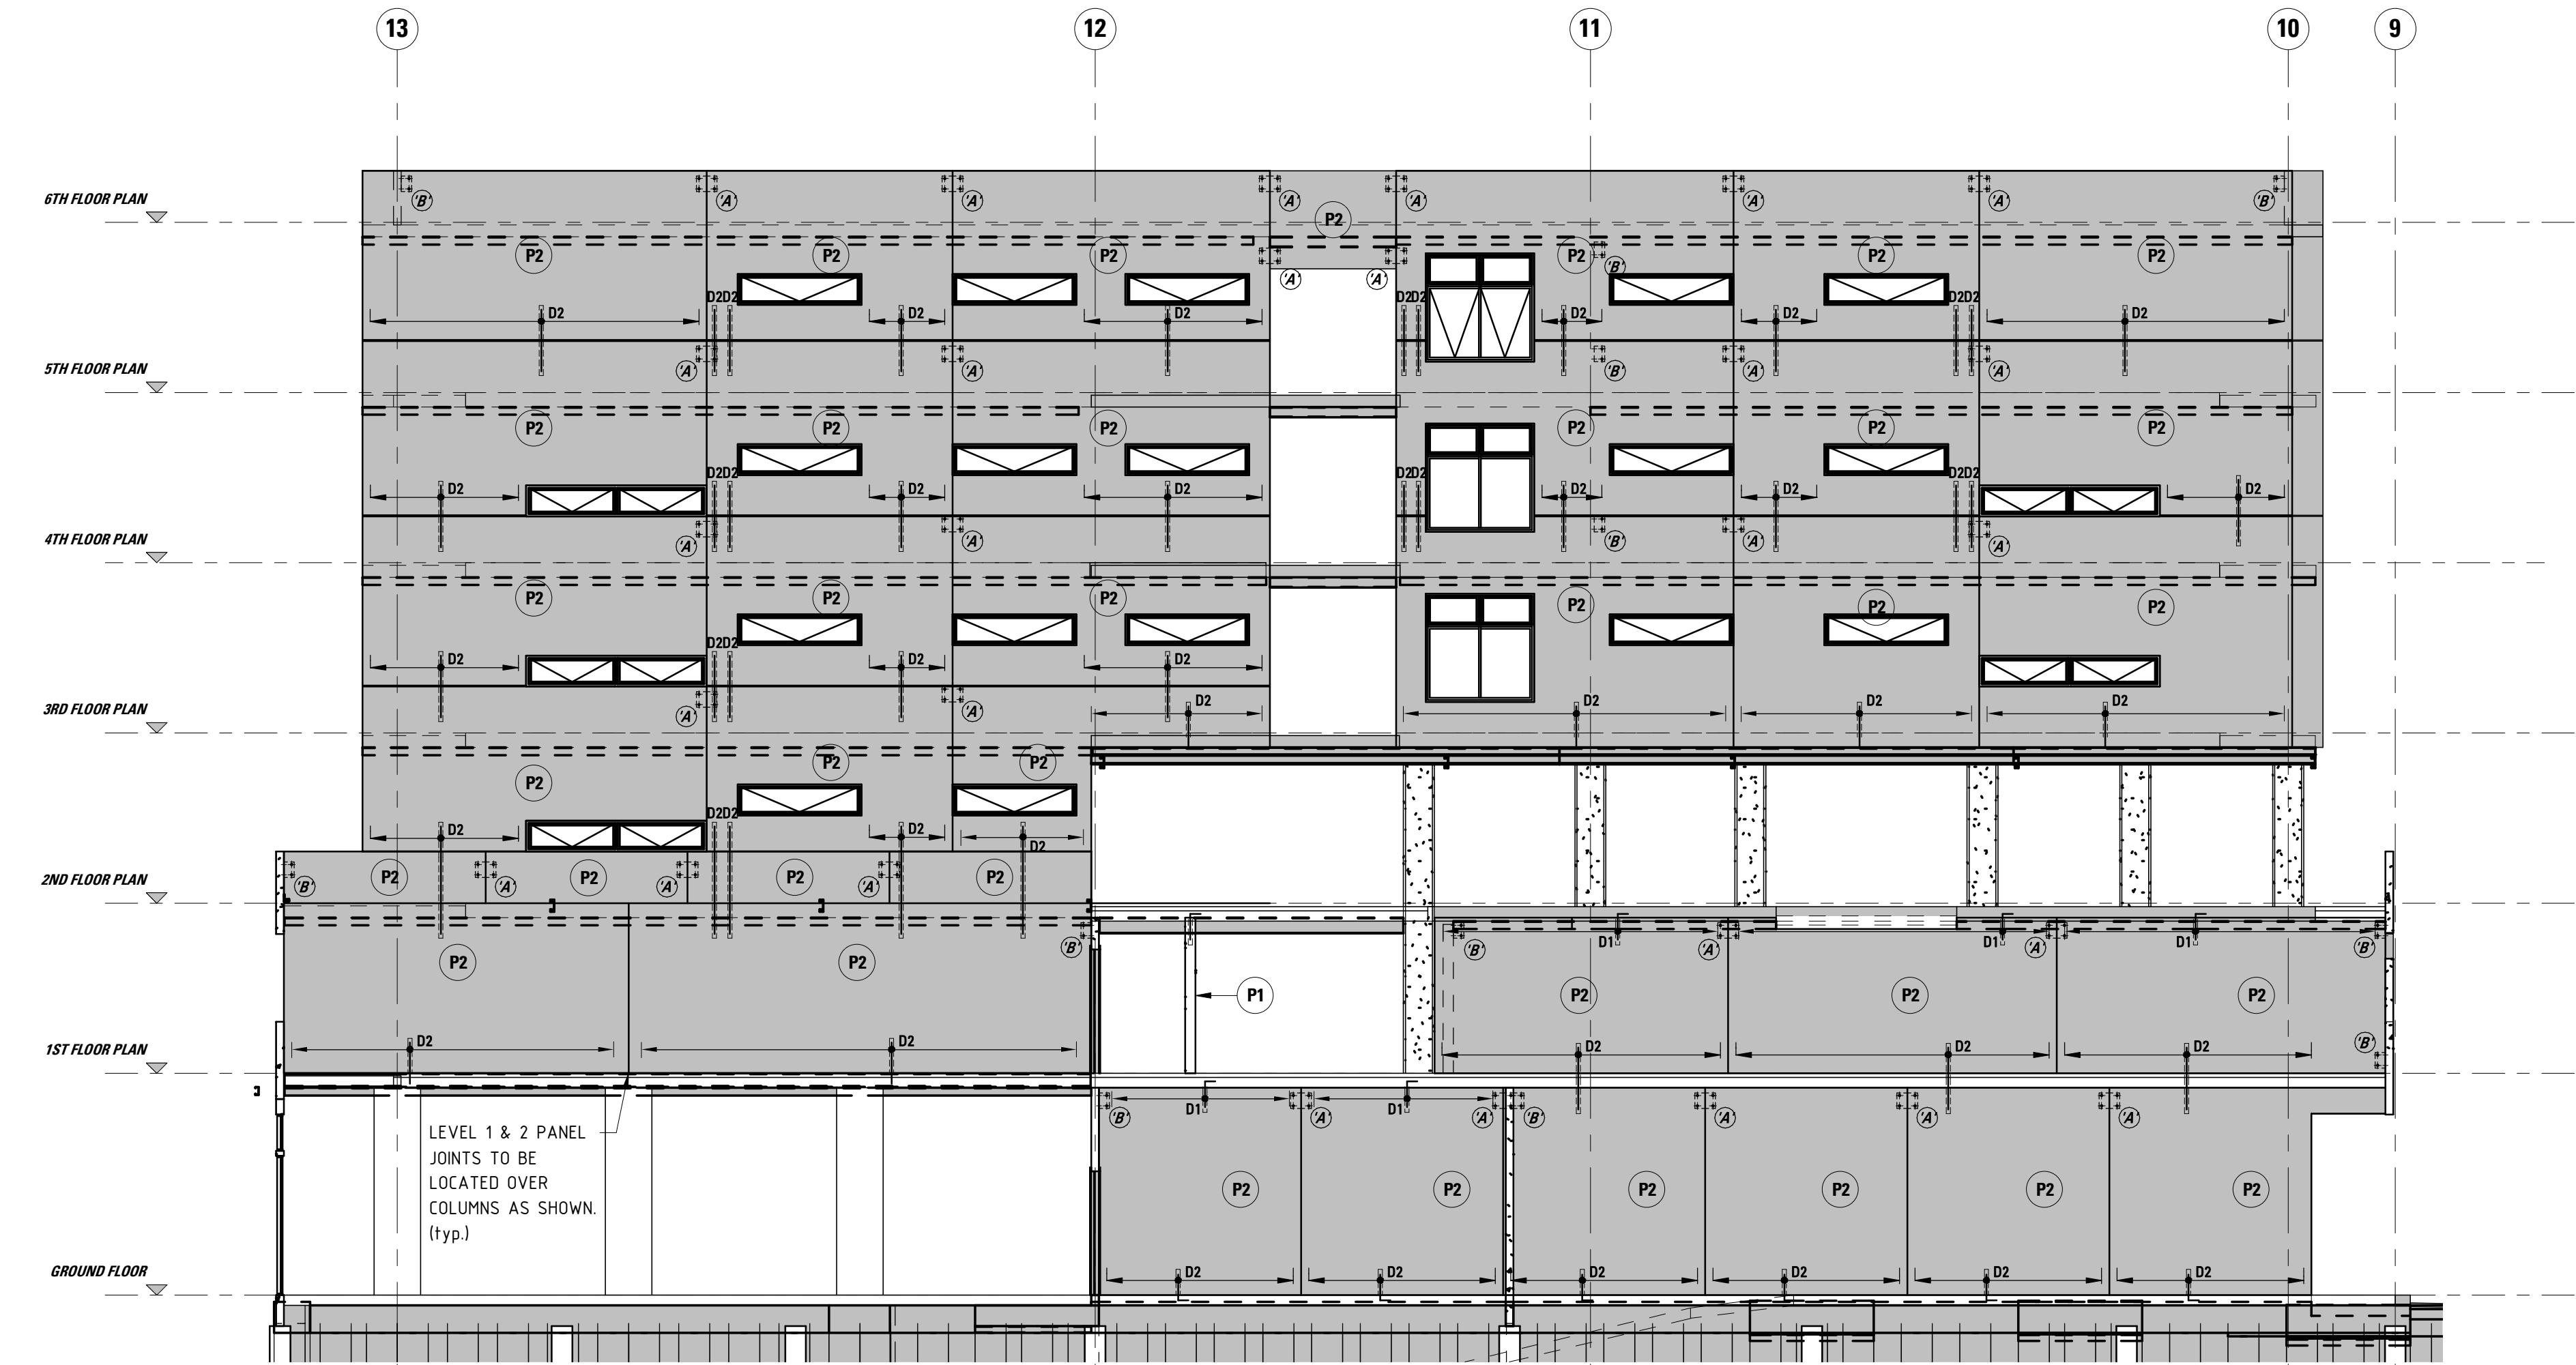

EXTERNAL PRECAST ELEVATION ALONG GRID A
SCALE 1:100

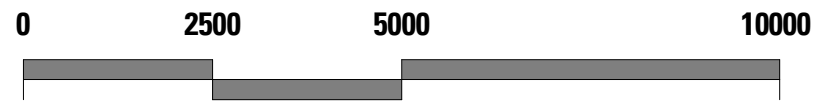

SCALE 1:100 @ A1

FOR CONSTRUCTION

06.05.20	REVISIONS AS CLOUDED	01	
Date	Revision	Issue	
PT Design			
PT Design Associates Pty Ltd 141-149 Hould St Adelaide SA 5000 T [08 8412 4300] F [08 8232 4311] E [ptdesign@ptdesign.net.au]			
Designer	RW	Drawn	BZ & MM
Approved	Approver	Date	07/05/2020 9:33:32 AM
STRUCTURAL		Sheet	9 of x
Project			
HYDE PARK PLACE 248 UNLEY ROAD, HYDE PARK SA			
Client			N +
CITIFY & BFC PTY LTD			
Drawing Title			Scale As indicated
EXTERNAL ELEVATIONS (Sheet 1)			
Drawing Number			Issue
20492-S12			01
Name: P:\2018\20492\3.5 Drawings (S)\Revit 2019\Local files\20492 - Structural Model_1_Maurice.rvt			
Date/Time 07/05/2020 9:33:32 AM © Copyright			